HVAC Replacement Project Hobson Street Site

Project TX186

Construction Documents
September 2025
NOCONA HOUSING AUTHORITY
400 Hobson St.; Nocona, Texas

Ms. Tara Hall; Executive Director



INDEX OF DRAWINGS				
	COVER			
AS1.1	SITE PLAN and BID SCHEDULE			
A1.1	ONE BEDRM. APARTMENT FLOOR PLAN, HVAC REPLACEMENT			
M1	MEP; ONE BEDRM. APT. PLAN, HVAC REPLACEMENT			
M2	MECHANICAL SCHEDULE & DETAILS			

Architectural construction documents, are intended to compose a detailed description of the design but are not intended to be detailed instructions for how to construct the project. Contractors must bring quality knowledge of construction practices, means and methods, as well as a skilled understanding of sequencing of construction and coordinating the work of subcontractors in order for the project to be successful.




James W. Dean Architect, LLC
LEED Accredited Professional Leadership in Energy & Environmental Design


8912 AUGUSTA DR. GRANBURY, TX 76049

PHONE: (817) 964-1830

Edmonds Engineering Services, LLC

1821 Line Ave.; Shreveport, LA 71101
Phone: (318) 674-1000
Mechanical / Electrical

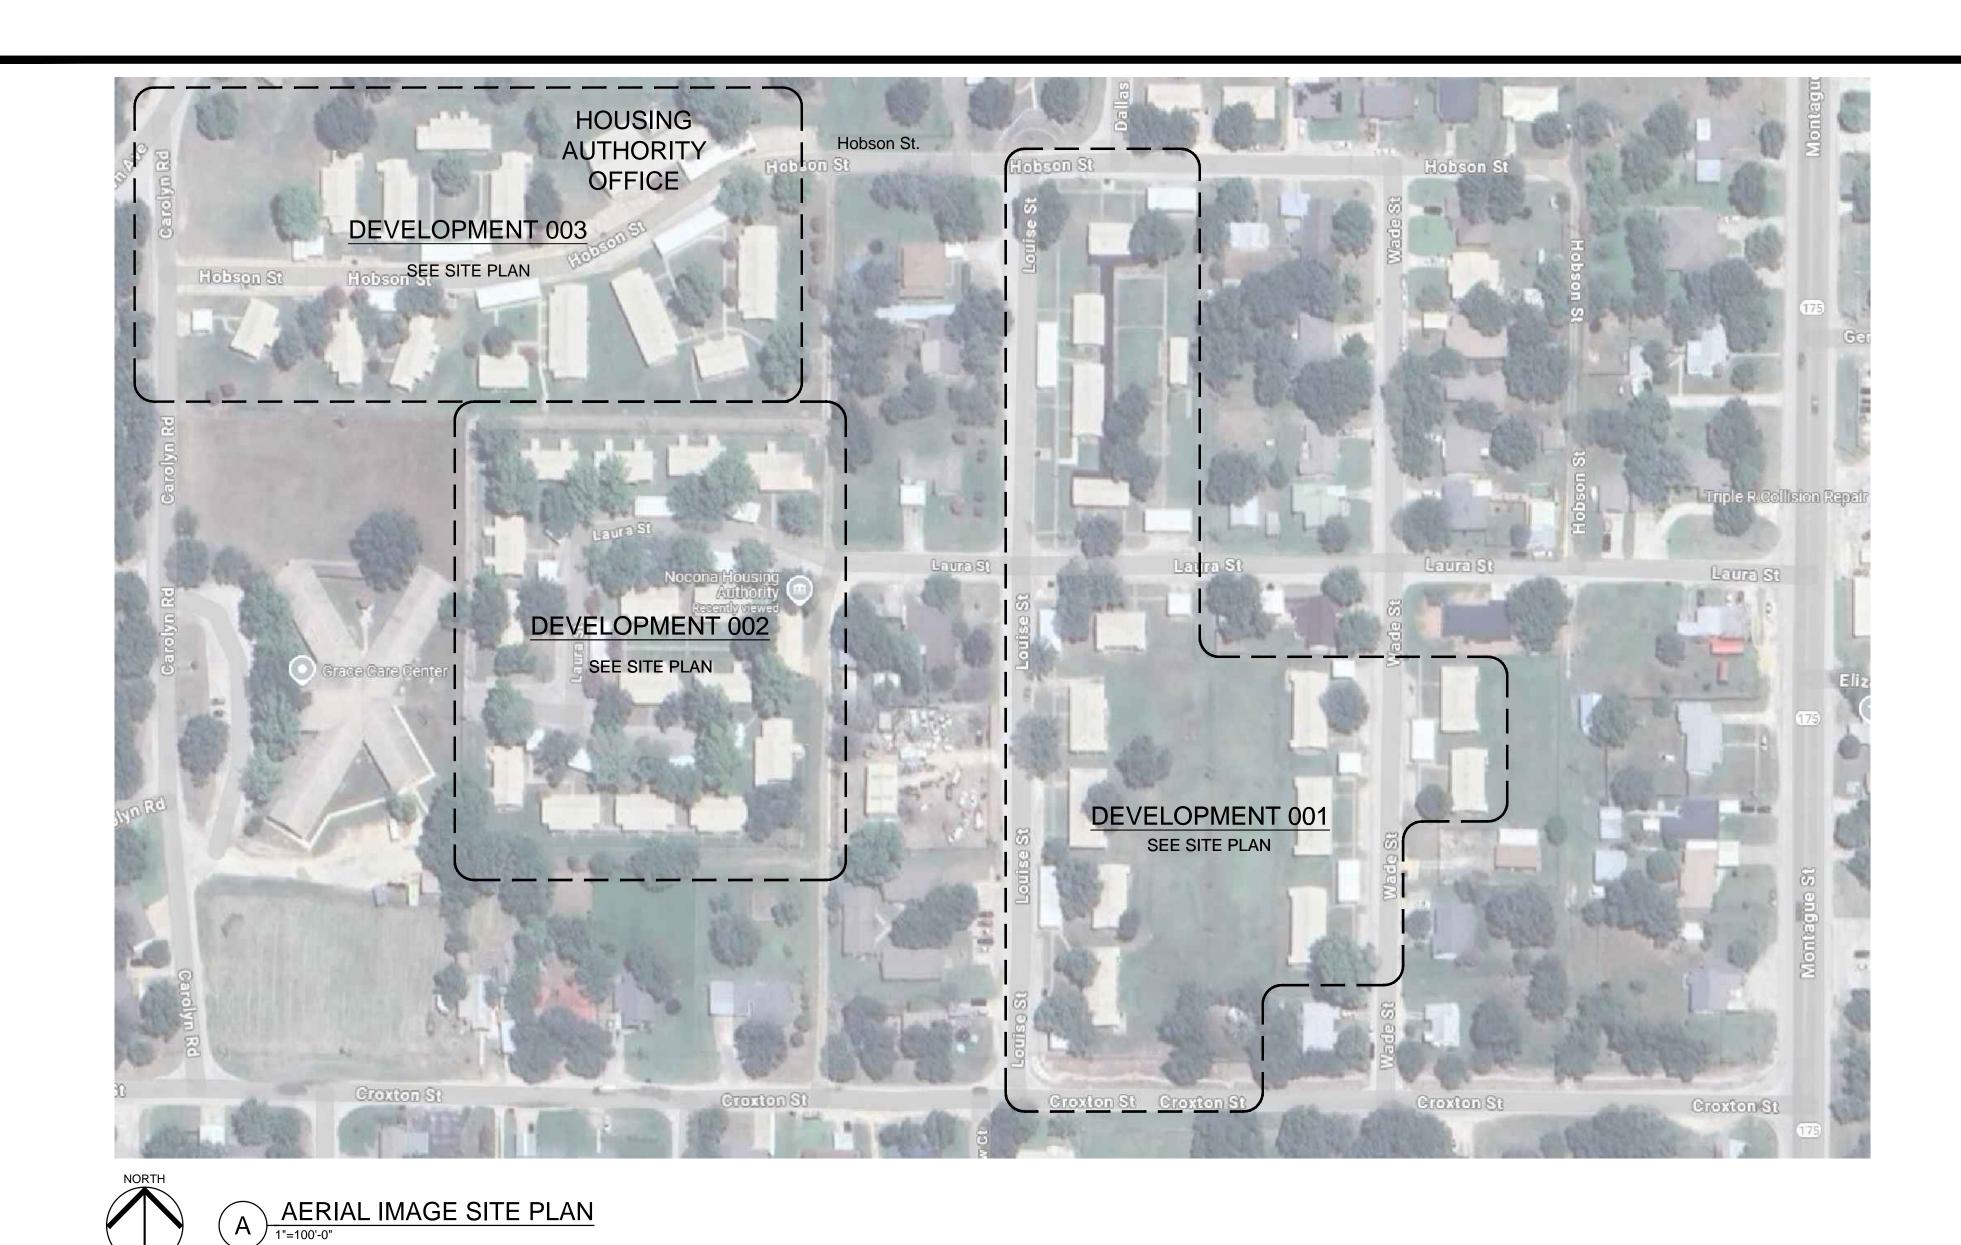


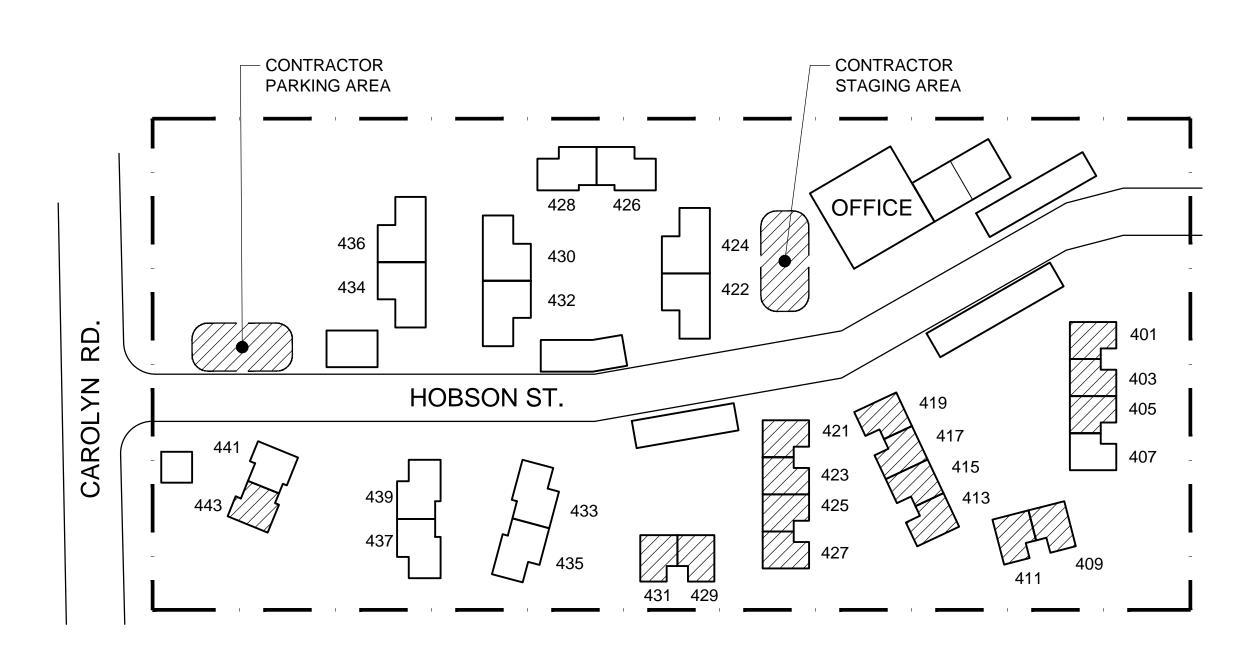


DEVELOPMENT 002- SITE PLAN

1"=60'-0"

BID SCHEDULE					
		No. Units			
BASE BID	APARTMENTS: 401, 403, 405, 413, 415, 417, 419, 421, 423, 425, 427. Quad Buildings	11			
ADDITIVE ALTERNATE NO.1	APARTMENTS: 409, 411, 429, 431. Duplex Buildings	4			
ADDITIVE ALTERNATE NO.2	APARTMENT: 443. Duplex Building.	1			

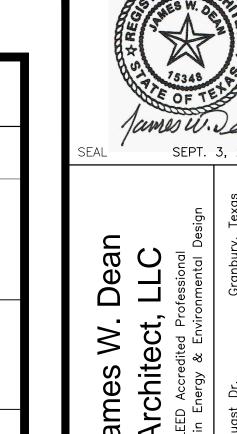

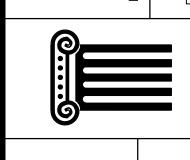


	HVAC RFPLACEMENT PROJECT HORSON ST		NOCONA HODONING ACINORII →	XT ANCOCK		SHEET TITLE	AITE DIANS & BIN SCHEDIII E	
REVISIONS								
DATE								
DAT		SE	PT.	,	20	25		
PLA	AN I		25-	-N	HA	4		
DRA	AWN		r JWI	D/	BS	<u> </u>		
C		NO						1

SITE LEGEND: APARTMENT NUMBER 211, 209 - BUILDING OUTLINE - UNITS IN PROJECT

SHEET NO.


AS1.1

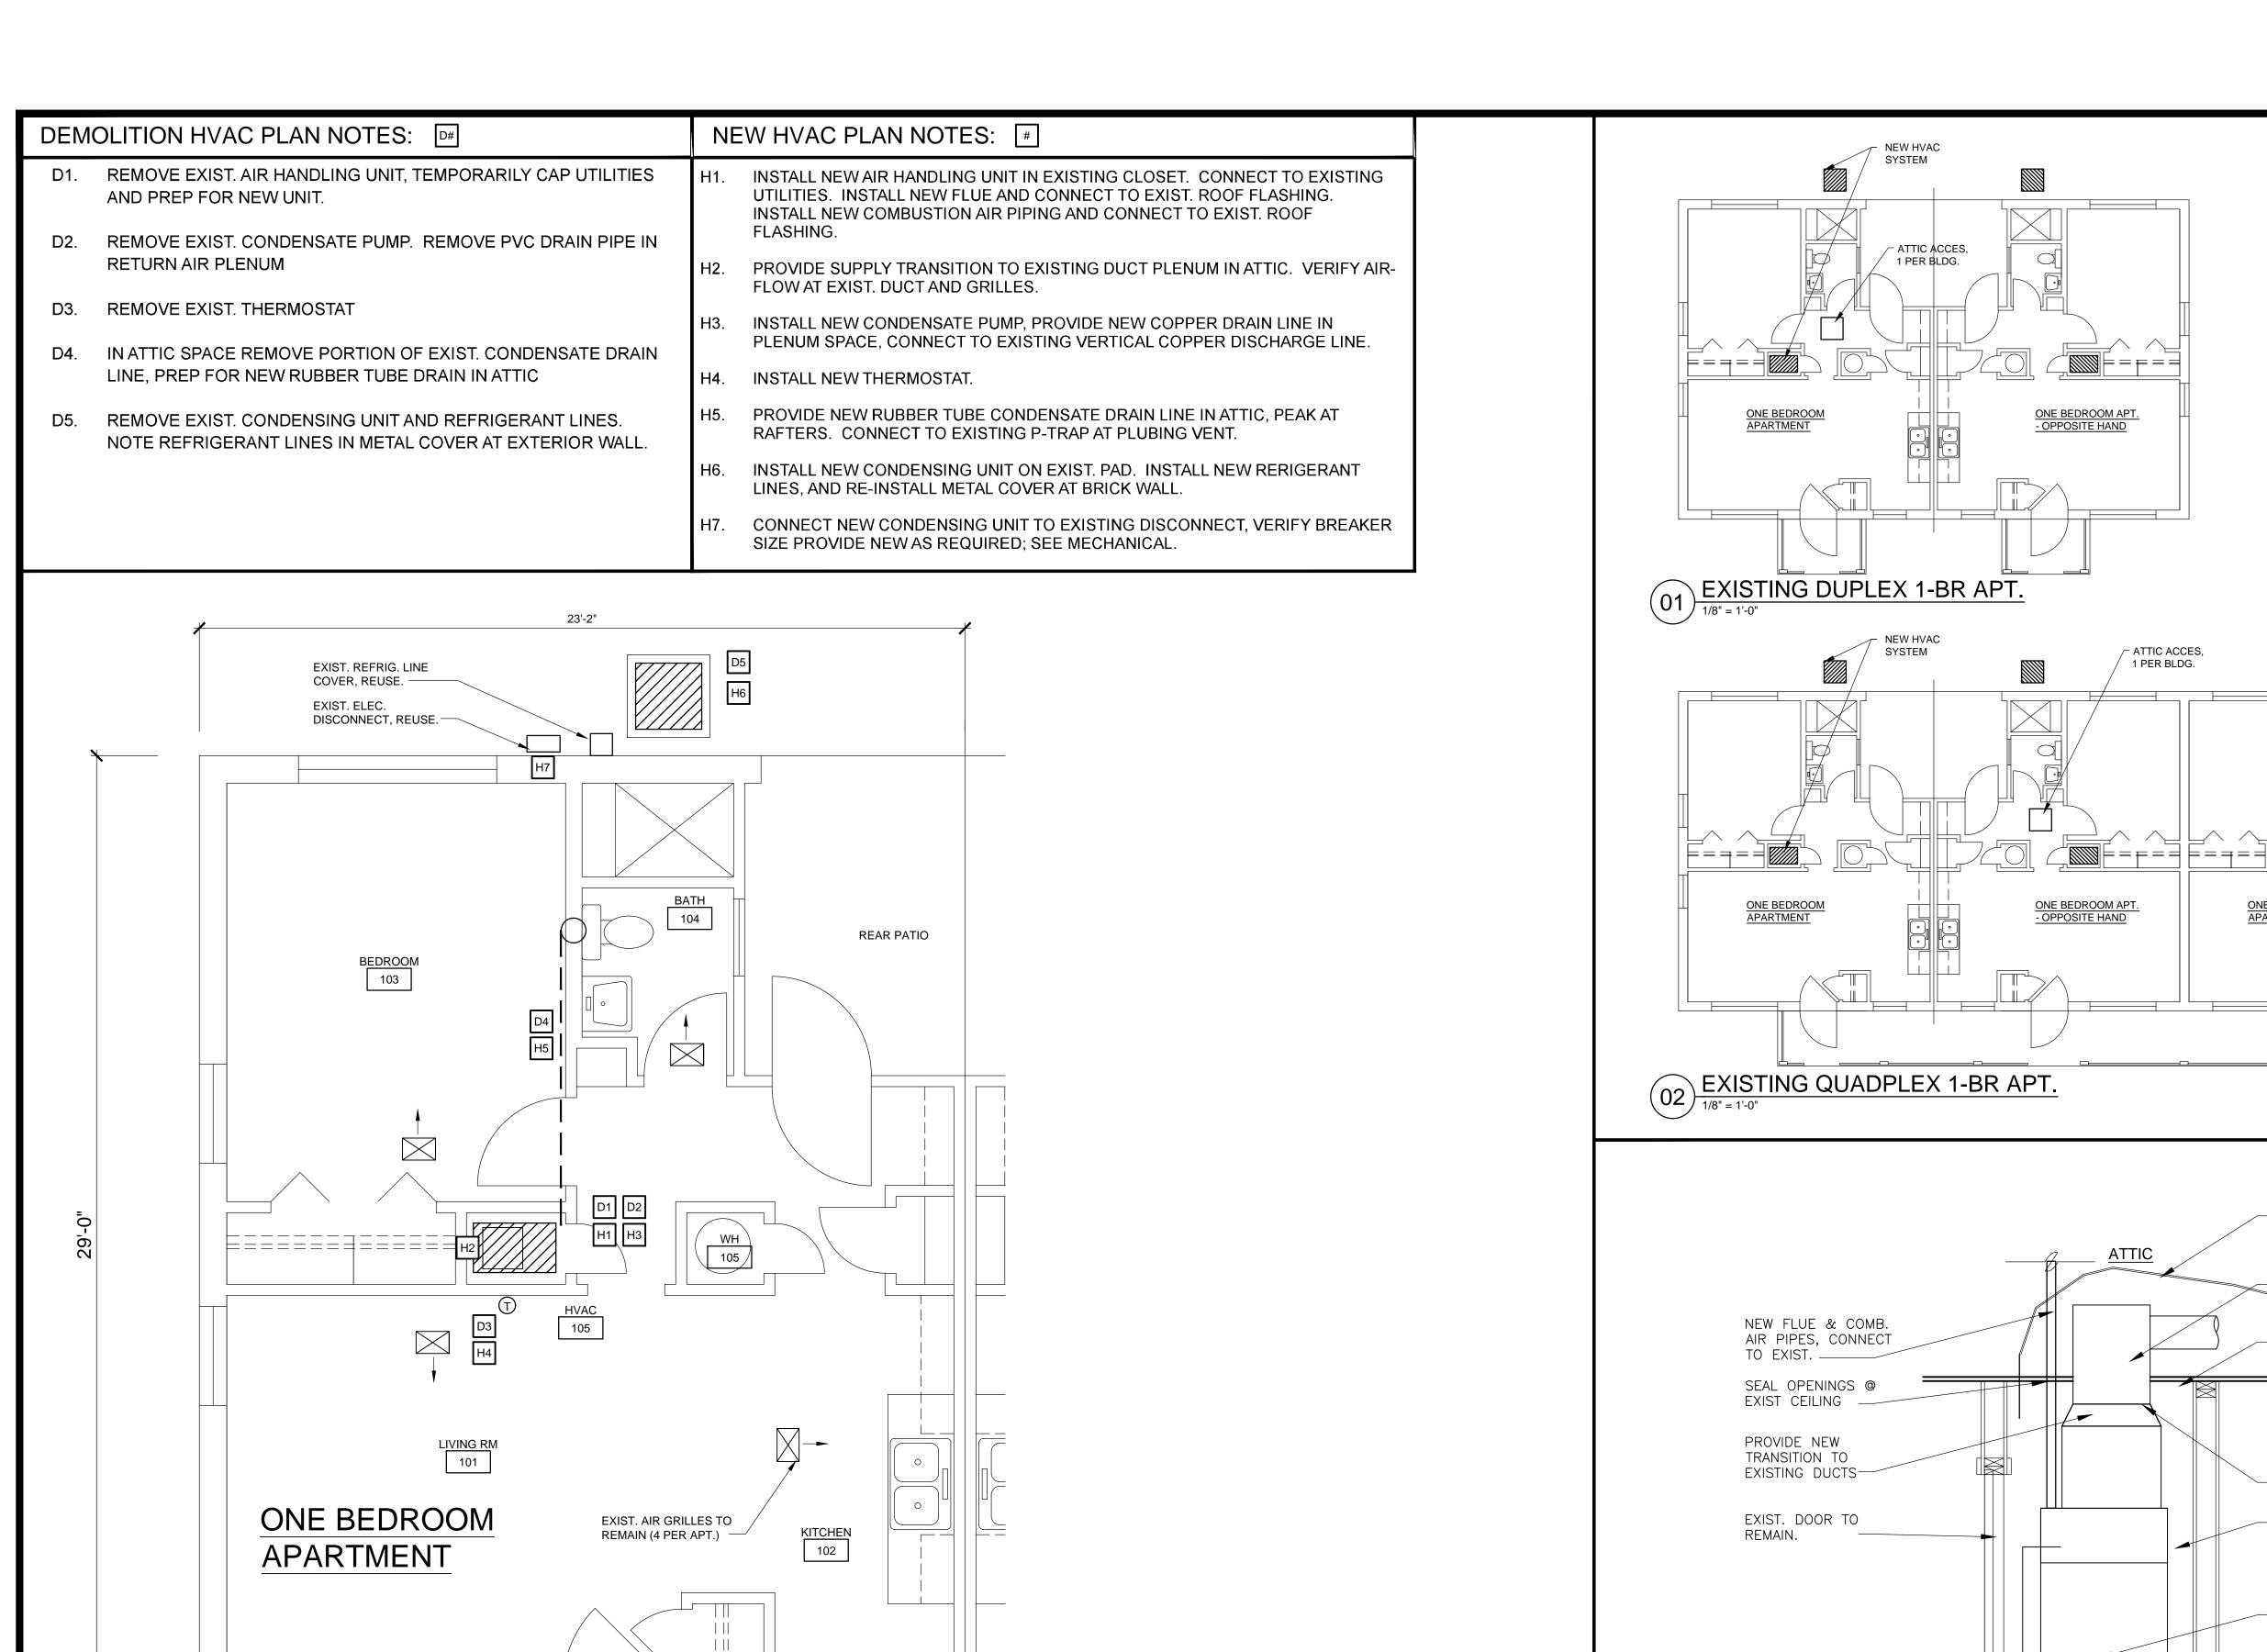

FLOOR PLAN ONE BEDROOM HVAC IMPROVEMENTS

3/8" = 1'-0"

NOTE: CONTRACTOR SHALL VERIFY EXISTING BUILDING
CONDITIONS AND DIMENSIONS. DIMENSIONS PROVIDED
AS A GENERAL GUIDE FOR APARTMENT SIZE.

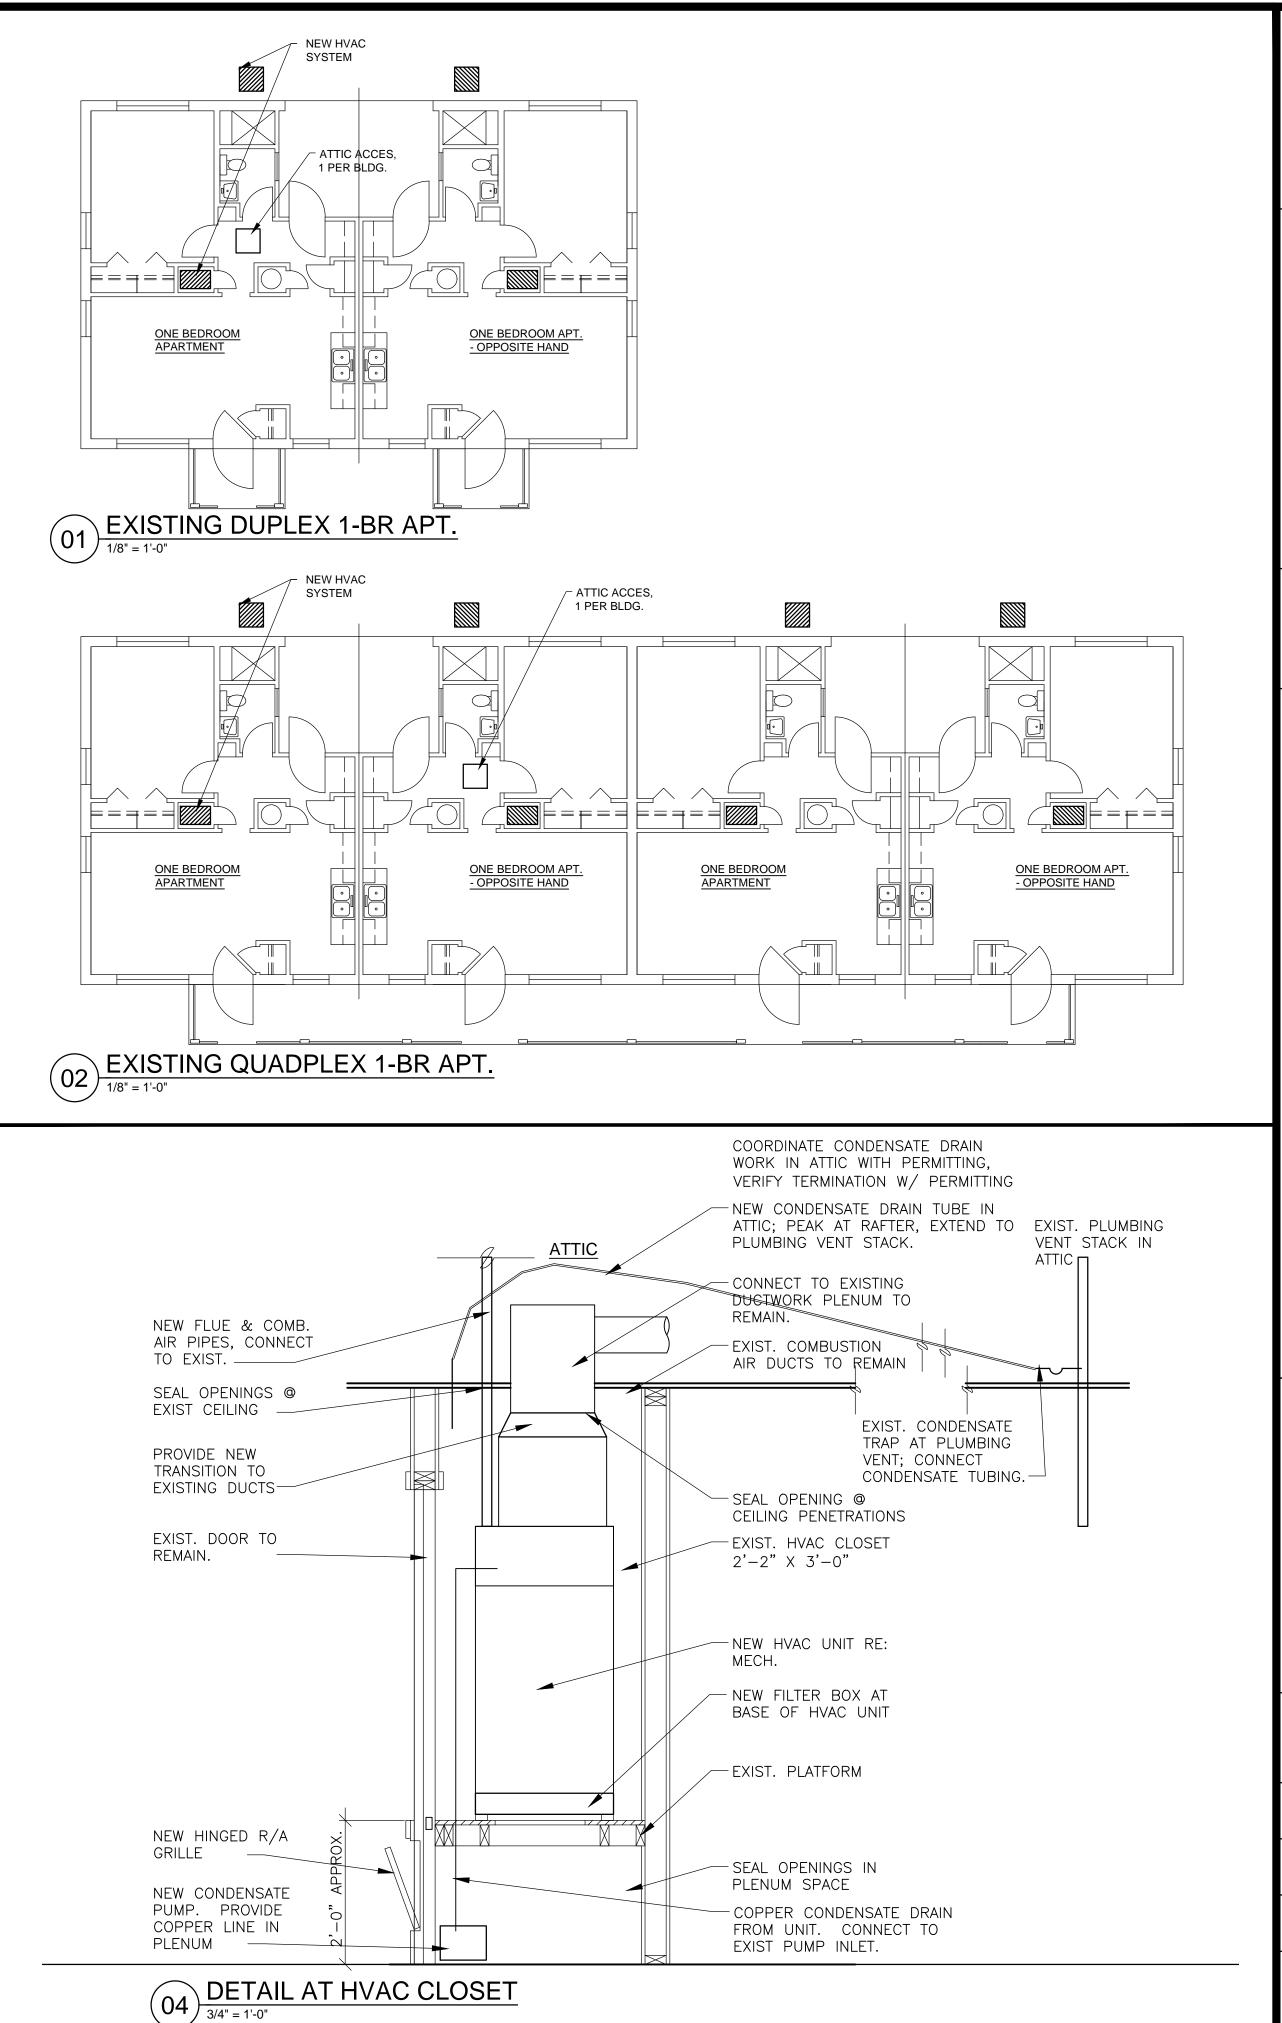

James W. Architect,

SON

OJECT

EPLACEMENT P HOUSING AUT TX

SEPT., 2025

25-NHA

JWD/BS


A1.1

PLAN NO.

DRAWN BY

SHEET NO.

BEDROOM

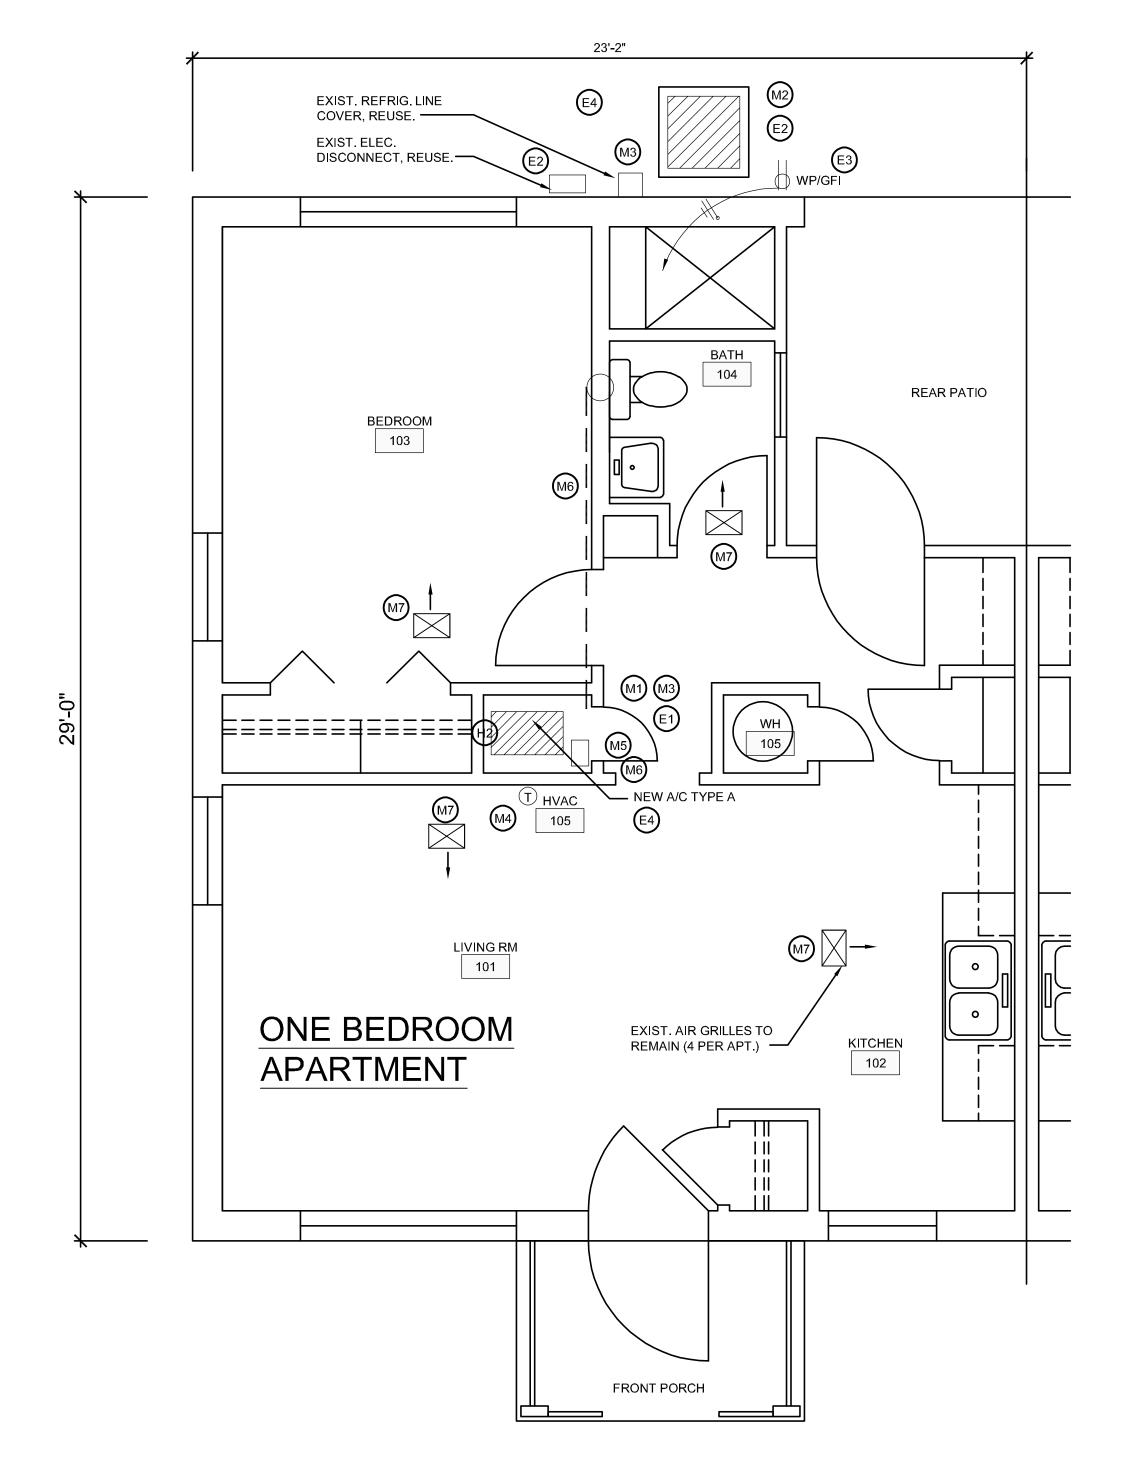

MECH. / ELEC. HVAC PLAN NOTES: (M#)

M1 DISCONNECT, REMOVE, AND DISCARD EXISTING GAS FURNACE / DX COOLING COIL AND INSTALL NEW UNIT ON EXISTING R/A PLENUM (REF. ARCH. PLANS).
DISCONNECT EXISTING GAS AND CONDENSATE DRAIN PIPING AND RE-CONNECT TO NEW UNIT. DISCONNECT EXISTING S/A PLENUM AND RE-CONNECT TO NEW UNIT, PROVIDE ALL NECESSARY TRANSITIONS AS REQUIRED. DISCONNECT EXISTING FLUE AND COMBUSTION AIR, AND RE-CONNECT TO NEW FURNACE.
PROVIDE NEW FILTER BOX AT THE BASE OF THE NEW FURNACE, WITH HINGED ACCESS DOOR.

THE EXISTING FURNACES ARE HIGH EFFICIENCY AND CURRENTLY HAVE TWO-PIPE SYSTEM FOR FLUE AND COMBUSTION AIR. PROVIDE NEW FLUE AND COMBUSTION AIR PIPING PER MANUFACTURER. VERIFY FLUE TERMINATIONS AT THE ROOF.

CONTRACTOR SHALL REPORT ANY DISCREPANCIES SUCH AS MISSING COMBUSTION AIR DUCTS, FAULTY GAS LINES. CONTRACTOR SHALL INSPECT EXISTING GAS LINES FOR LEAKS AND INTEGRITY, AND REPORT TO THE ARCHITECT IN WRITING.

- M2 DISCONNECT, REMOVE, AND DISCARD EXISTING OUTDOOR CONDENSING UNIT AND PROVIDE NEW CONDENSING UNIT. EXISTING PAD TO REMAIN, VERIFY. REPORT DAMAGED OR MISSING PADS TO THE ARCHITECT IN WRITING. INSTALL CONDENSING UNIT LEVEL AND SECURE.
- M3 DISCONNECT, REMOVE, AND DISCARD EXISTING REFRIGERANT PIPING BETWEEN THE EXISTING DX COOLING COIL AND THE OUTDOOR CONDENSING UNIT AND EXISTING PIPING COVER. PROVIDE NEW REFRIGERANT PIPING SIZED AND ROUTED IN STRICT ACCORDANCE WITH NEW EQUIPMENT MANUFACTURER'S INSTRUCTIONS AND LOCAL CODES.

PROVIDE NEW REFRIGERANT PIPING COVER, SEE PLAN SHEET M2.

SLEEVE AND SEAL WALL PENETRATIONS WATER-TIGHT. PROVIDE 3/4" ARMAFLEX INSULATION ON THE SUCTION LINES.

- M4 DISCONNECT, REMOVE, AND DISCARD EXISTING THERMOSTAT AND CONTROL WIRING. PROVIDE NEW THERMOSTAT AND CONTROL WIRING.
- DRAWING AVC CONDENSATE DRAIN PIPING TO BE REPLACED PER ARCHITECT DRAWING AND NOTES. PROVIDE 3/4" INSULATION ON ANY GRAVITY CONDENSATE DRAIN PIPING AND TERMINATIONS IN ATTIC.

 EXTEND TO A/C COIL PRIMARY DRAIN CONNECTION. CONTRACTOR SHALL INSPECT INTEGRITY OF EXISTING CONDENSATE PIPING INSTALLATION AND TERMINATION AND REPORT TO THE ARCHITECT IN WRITING. PROVIDE 3/4" INSULATION ON GRAVITY CONDENSATE DRAIN LINE FROM COIL DRAIN PAN TO PUMP INTAKE.
- M6 DISCONNECT, REMOVE, AND DISCARD EXISTING CONDENSATE PUMP AND REPLACE WITH NEW PUMP SET EQUIVALENT TO THE EXISTING AND RE-CONNECT EXISTING CONDENSATE DRAIN LINE. PROVIDE INTEGRAL CHECK VALVE AT PUMP DISCHARGE.
- M7 EXISTING DUCTWORK AND DIFFUSERS TO REMAIN. CONTRACTOR SHALL INSPECT THE EXISTING DUCT SYSTEMS INTEGRITY AND REPORT TO THE ARCHITECT IN WRITING.


 PROVIDE INSULATED BOXES IN ATTIC FOR EACH DIFUSSER IF NOT ALREADY INSULATED. ALL DUCT JOINTS NEW AND EXISTING SHALL BE SEALED WITH

PROVIDE INSULATED BOXES IN ATTIC FOR EACH DIFUSSER IF NOT ALREADY INSULATED. ALL DUCT JOINTS NEW AND EXISTING SHALL BE SEALED WITH APPROVED DUCT SEALER.

REFRIGERANT PIPING SHALL BE TYPE L COPPER, SILVER SOLDERED.

NEW GAS PIPING SHALL BE SCHEDULE 40 THREADED BLACK STEEL ASTM 120 WITH SCREWED FITTINGS. PROVIDED DIELECTRIC UNIONS BETWEEN DISSILILAR METALS. GAS VALVES SHALL BE PLUG TYPE WITH SQUARE HEAD, SCREWED CONNECTIONS, A.Y. MCDONALD, ASTM B16.33, ALL BRONZE BODY, BRASS PLUG, 125 PSIG.

- E1 DISCONNECT EXISTING GAS FURNACE FAN, EXISTING CIRCUIT TO REMAIN FOR RE-CONNECTION TO NEW UNIT. PROVIDE A/C RATED WALL SWITCH, AS NEEDED.
- DISCONNECT EXISTING OUTDOOR CONDENSING UNIT. PROVIDE NEW NEMA 3R DISCONNECT SWITCH FUSED FOR NEW CONDENSING UNIT, VERIFY. VERIFY EXISTING CIRCUIT SIZE AND CIRCUIT BREAKER FOR COMPATIBILITY WITH NEW OUTDOOR CONDENSING UNIT. REPORT ANY DISCREPANCIES TO THE ARCHITECTIN WRITING.
- AS "UNIT PRICE" INSTALL NEW GFI OUTLET W/ WATERPROOF COVER. EXTEND CICUIT WIRE TO EXISTING PANEL AND PROVIDE NEW 20 AMP BREAKER. VERIFY LOCAITON OF EXISTING ELECTRICAL PANEL. PROVIDE METAL CONDUIT AT EXTERIOR OF BUILDING.
- E4 ALL NEW ELECTRICAL WORK SHALL BE DONE IN STRICT ACCORDANCE WITH NFPA 70 (NEC) AND LOCAL CODES, INCLUDING BUT NOT LIMITED TO GROUNDING, MINIMUM WIRE SIZE, DISCONNECTING MEANS, OVERCURRENT PROTECTION.

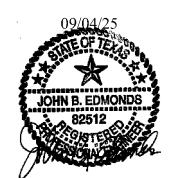

James W. Dean Architect, LLC

Leadership ii 8912 Augu

CEMENI PROJECI, HOBS USING AUTHORITY

NOCONA HOUS
NOCONA, TX

DATE

SEPT., 2025

PLAN NO.

25-NHA

DRAWN BY
JBE

SHEET NO.

M1

01 FLOOR PLAN ONE BEDROOM HVAC REPLACEMENT

NOTE: SIMILAR UNITS ARE OPPOSITE HAND

TYPICAL EQUIP. GAS CONNECTION DETAIL

NO SCALE



B DETAIL - CONDENSING UNIT ON GROUND

FILTER/DRYER

SEE ARCH FOR PIPING COVER —


CONDENSATE

➤ RL, RS ALONG OUTSIDE WALL


BREAK & PATCH WALL — TO MATCH EXISTING

CONDENSING UNIT—


REINFORCED CONCRETE PAD -

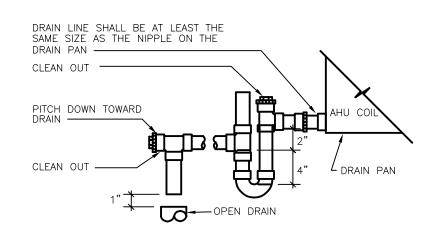



C DETAIL - AHU CONDENSATE DRAIN
NO SCALE

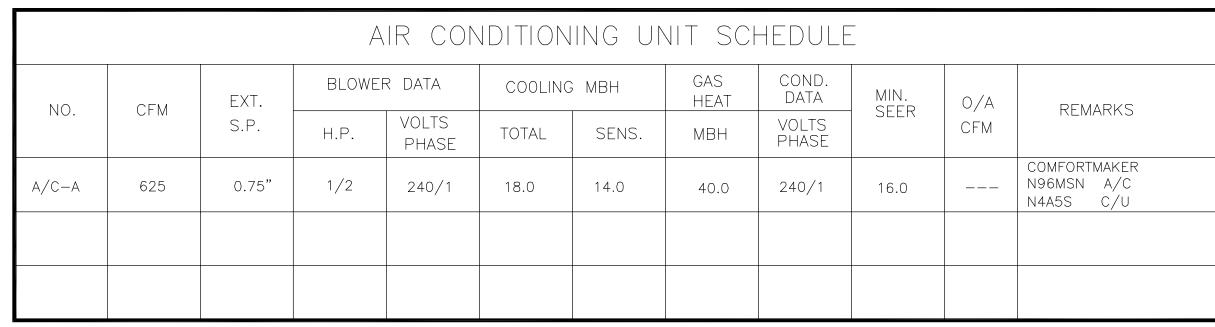


COOLING E.A.T. = 80FDB/67FWB, 95FDB OUTDOOR (ARI CONDITIONS)

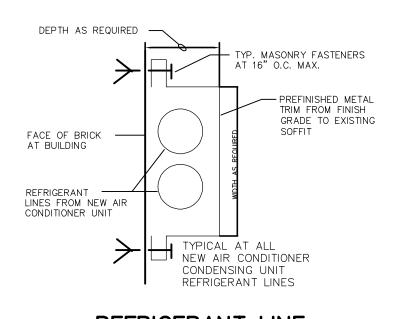


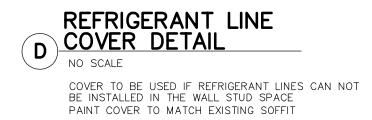

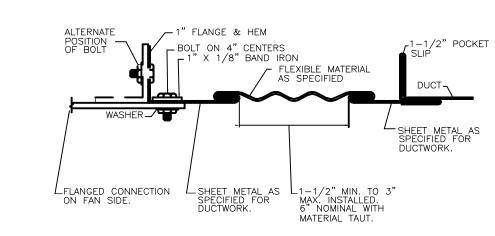


E DETAIL - FLEX DUCT CONNECTION

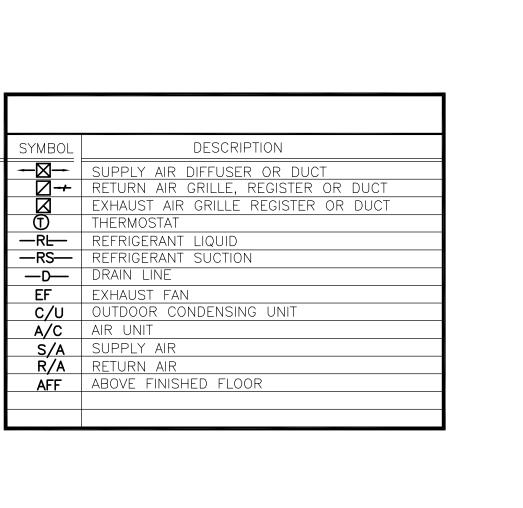

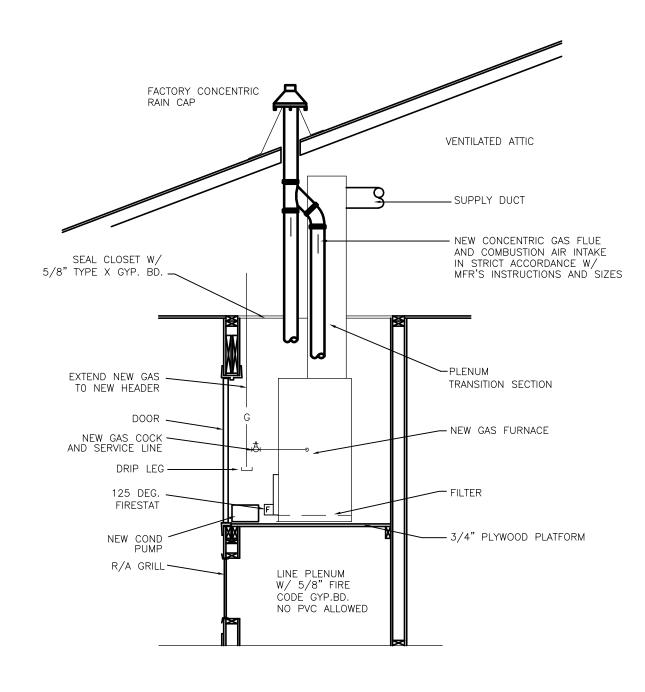



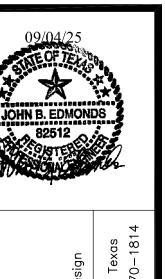

James W. Dean Architect, LLC

 \vdash HOBSON PROJECT, THORITY PROJECT NAME
HVAC REPLACEMENT PF
NOCONA HOUSING AUTH
NOCONA, TX

DATE

SEPT., 2025 PLAN NO. 25-NHA

DRAWN BY JBE

SHEET NO. M2

SYMBOL	DESCRIPTION							
Ф	DUPLEX RECEPTACLE							
#	QUAD RECEPTACLE							
∇	TELEPHONE JACK							
\$	SINGLE POLE SWITCH							
	CATV BOX & OUTLET							
0	JUNCTION BOX							
GFI	GROUND FAULT							
WP	WEATHERPROOF							
AFF	ABOVE FINISHED FLOOR							
60	SMOKE DETECTOR							
급	DISCONNECT SWITCH (FUSE SIZE AS INDICATED)							
*	ARROW REPRESENTS: HOMERUN TO PANEL TICKS REPRESENT: GROUND, PHASE LEG, NEUTRAL							